



FOUNDATION FORMWORK PLAN

SCALE 1:100

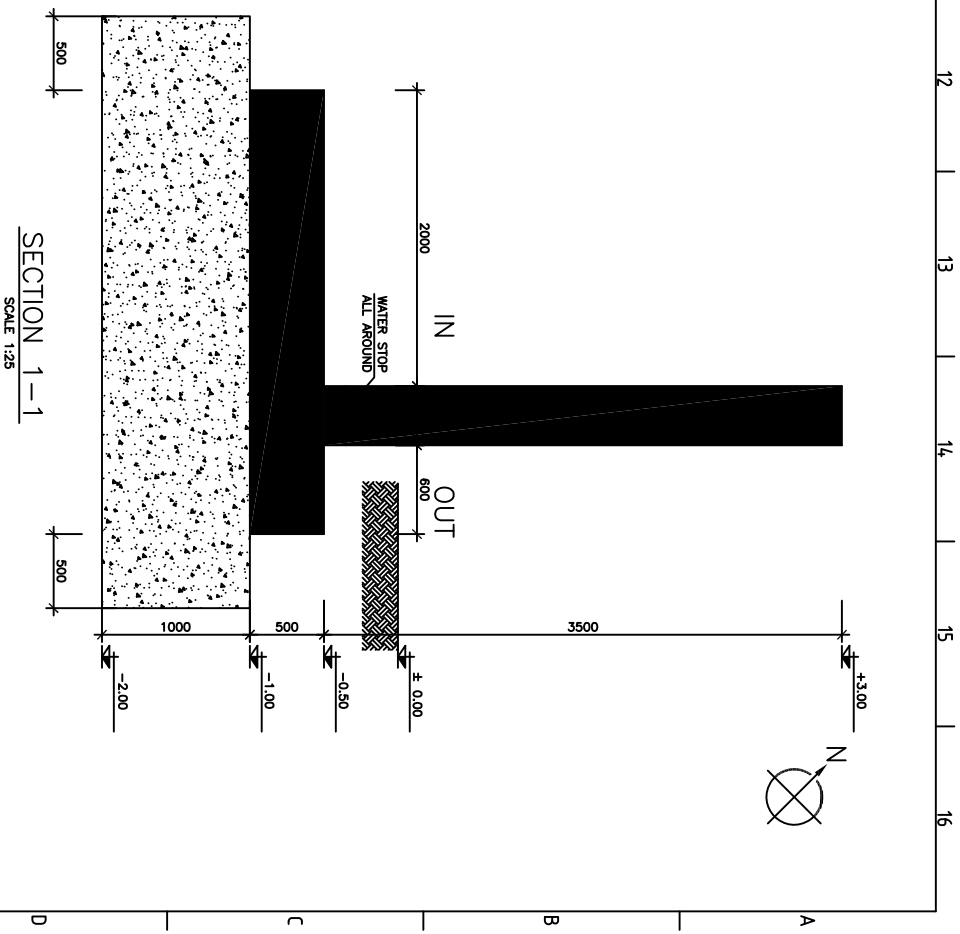


SECTION 1-1

SCALE 1:25

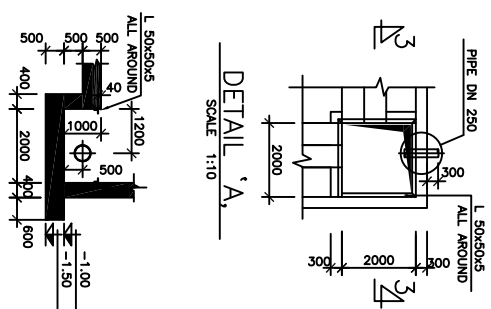

DETAIL 'A'

SCALE 1:10

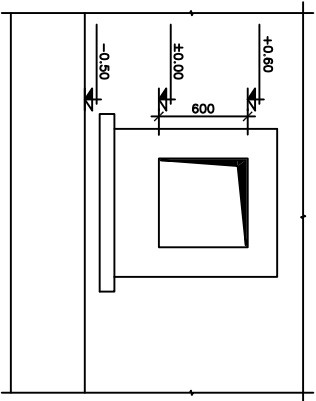

VIEW 'a'




SCALE 1:25

NOTES:


- 1-ALL THE PIPES SHALL BE SEAMLESS CARBON STEEL OF MATERIAL A106 GR. B CONFORMING TO STANDARD ANSI B36.10 SCH40.
- 2-PIPE PROJECTION FROM EACH SIDE OF THE DKE SHALL BE 250 mm.
- 3-FOR SECTIONS 2-2 SEE DWG. NO. ST14.5.04.0

±0.00 ≡ +284.00

Drawing Title:		Customer:	
HEAVY FUEL OIL STORAGE TANK		PAYVAND_E_GOLESTAN	
FOUNDATION FORMWORK PLAN			
General Arrangement Drawing			
Designed	DATE	Signature	Rev.
Drawn	DATE	Signature	Rev.
Checked	DATE	Signature	Rev.
Approved	DATE	Signature	Rev.
Project No.	Scale	Drawing No.	Rev.
353	1:353.ST.14.5.01.00	0	

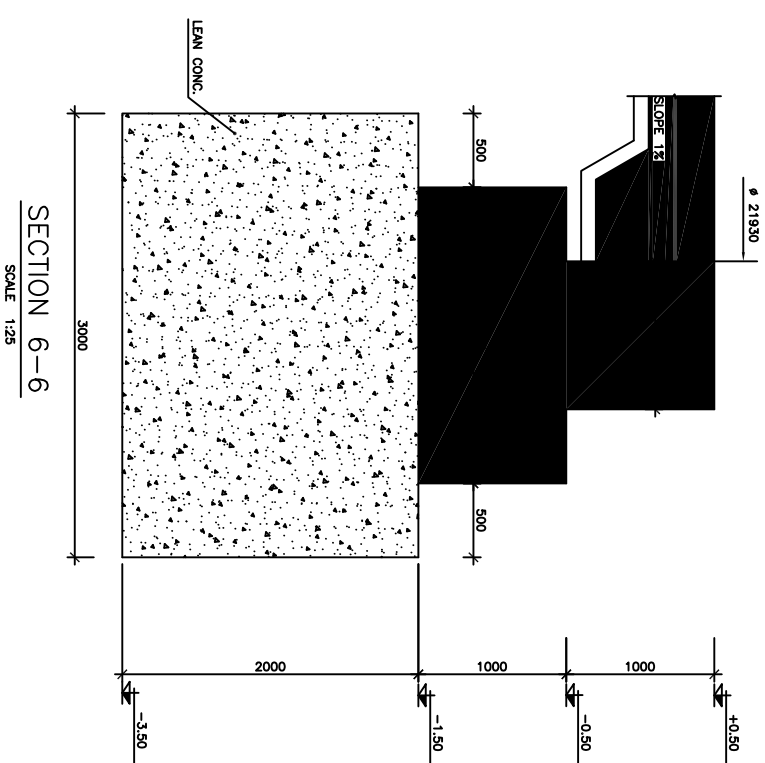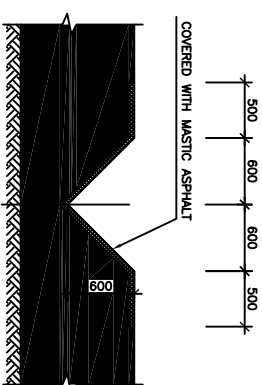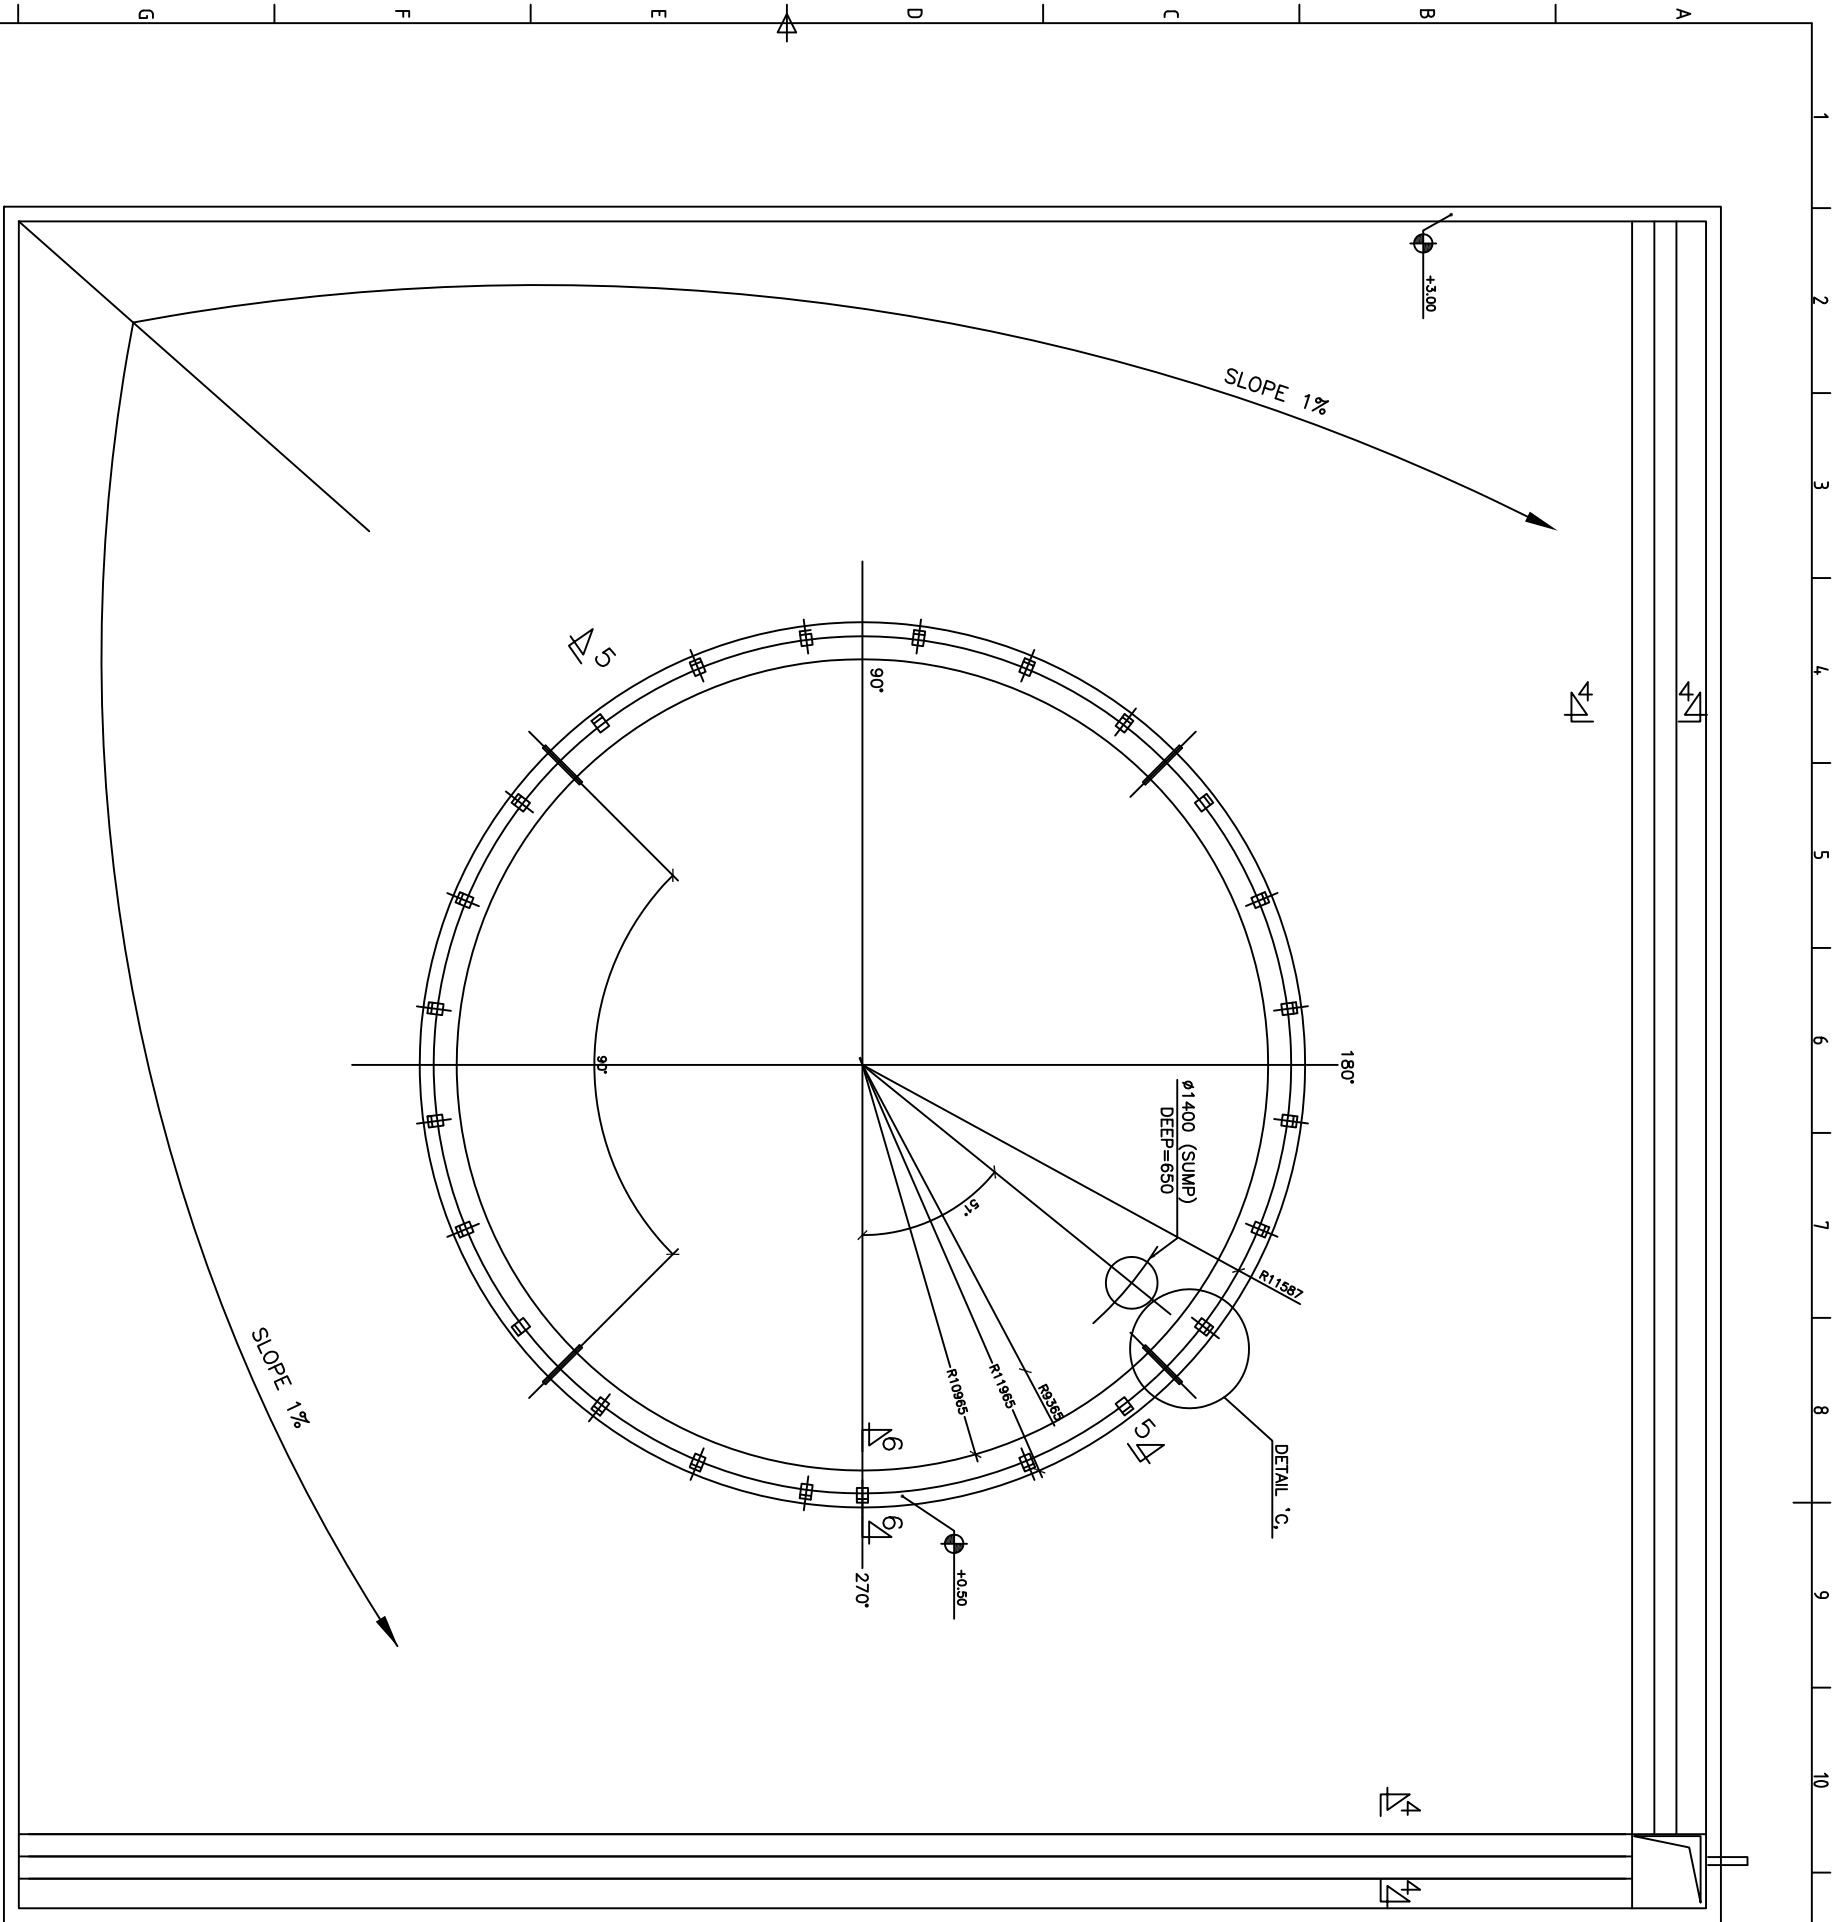


Drawing Title:				Customer:			
HEAVY FUEL OIL STORAGE TANK				PAYVAND_E_GOLESTAN			
PAVEMENT FORMWORK PLAN							
General Arrangement Drawing							
Designed	Rev. 1	Signature	Rev. 0	Description	By	Date	
Drawn	Rev. 2	Signature			R.D.	28/7/2	
Checked		Signature					
Approved		Signature					
Project No.:	Scale :			Drawing No.:			Rev.
353	1:353.ST.14.5.02.00			0			

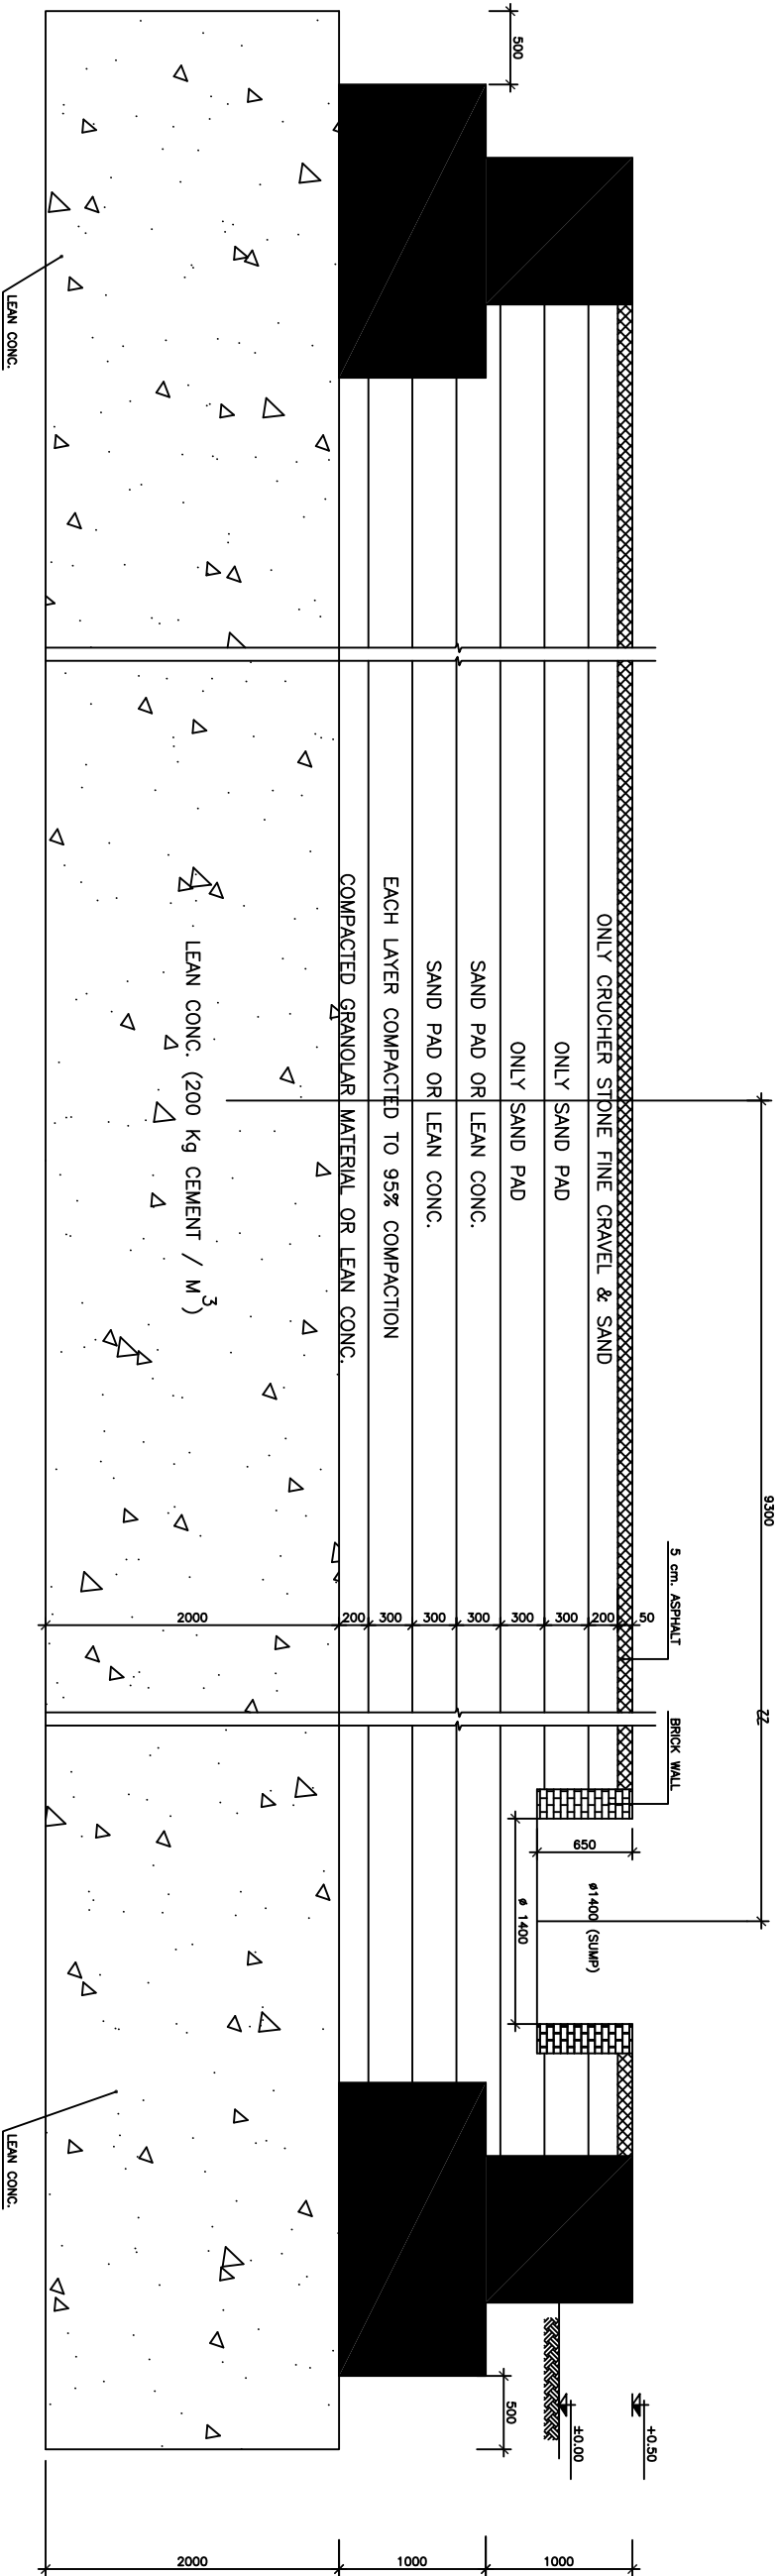

TYPICAL DETAIL OF BASE COURSE FOR HEAVY FUEL OIL STORAGE TANK

SCALE 1:25

SECTION 5-5

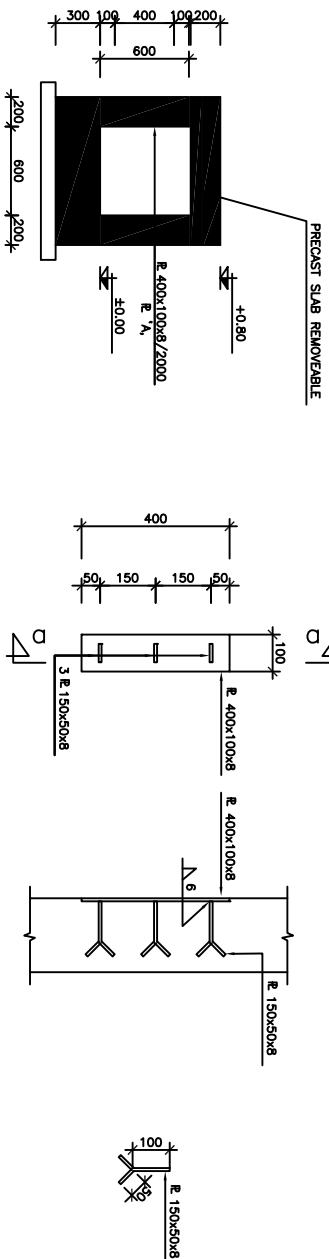

SECTION 2-2

SCALE 1:25


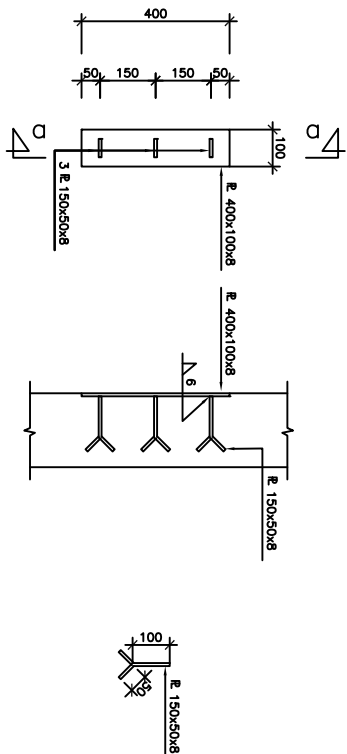


PLATE 'A,

SCALE 1:10

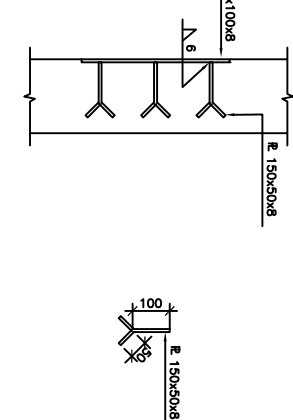

SECTION 5-5

SCALE 1:10


Drawing Title: HEAVY FUEL OIL STORAGE TANK DETAILS				Customer: PAYVAND_E_GOLESTAN			
General Arrangement Drawing							
Designed	Rev. 1	Signature	Rev.	Description	By	Date	
Drawn	Rev. 2	Signature	Rev.		R.D.	28/7/2	
Checked		Signature					
Approved		Signature					
Project No.:	Scale :	Drawing No.:					



353


1:353.ST.14.5.04.00

0

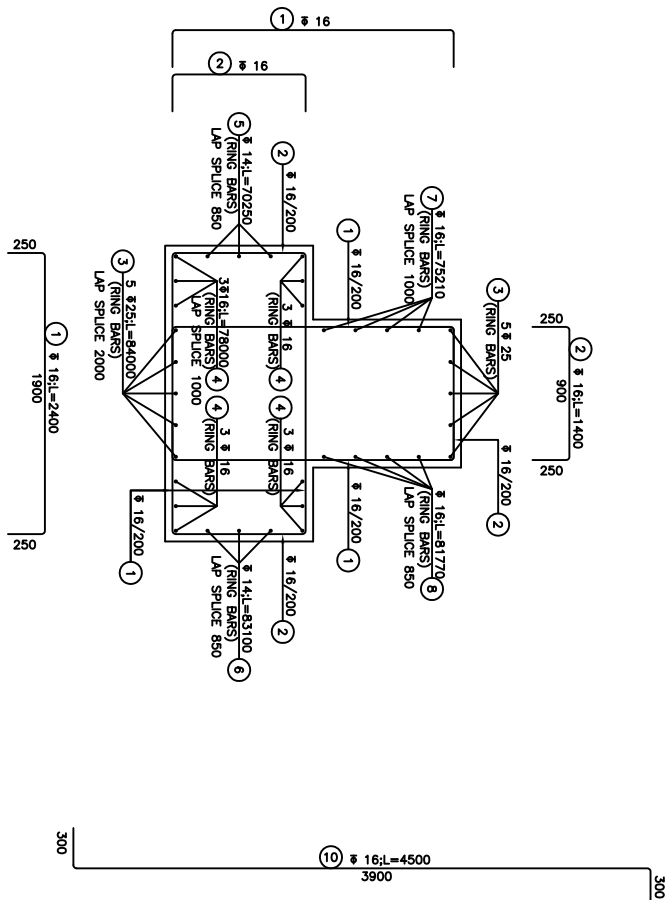


CROSS SECTION OF TANK SHELL

SCALE 1:25

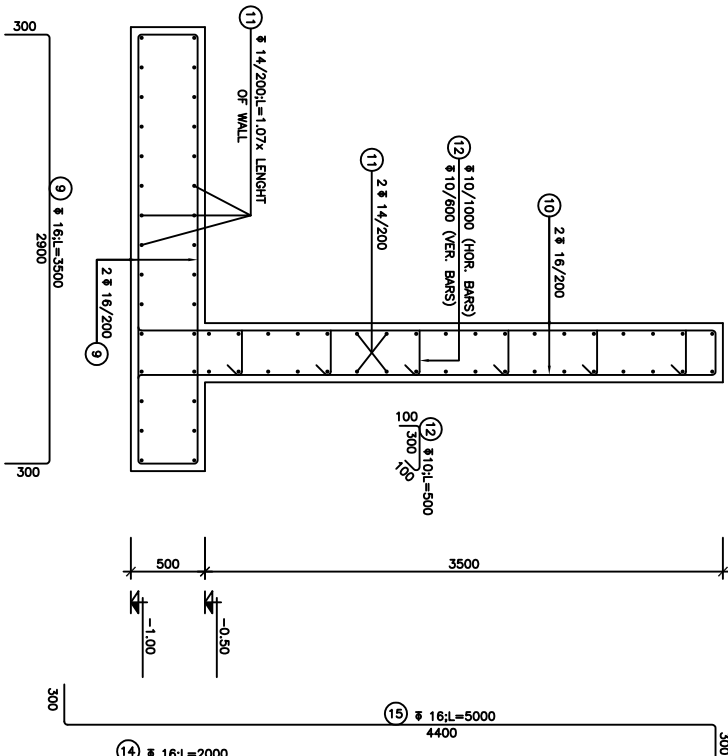


RETAINING WALL REINFORCEMENT

SCALE 1:25

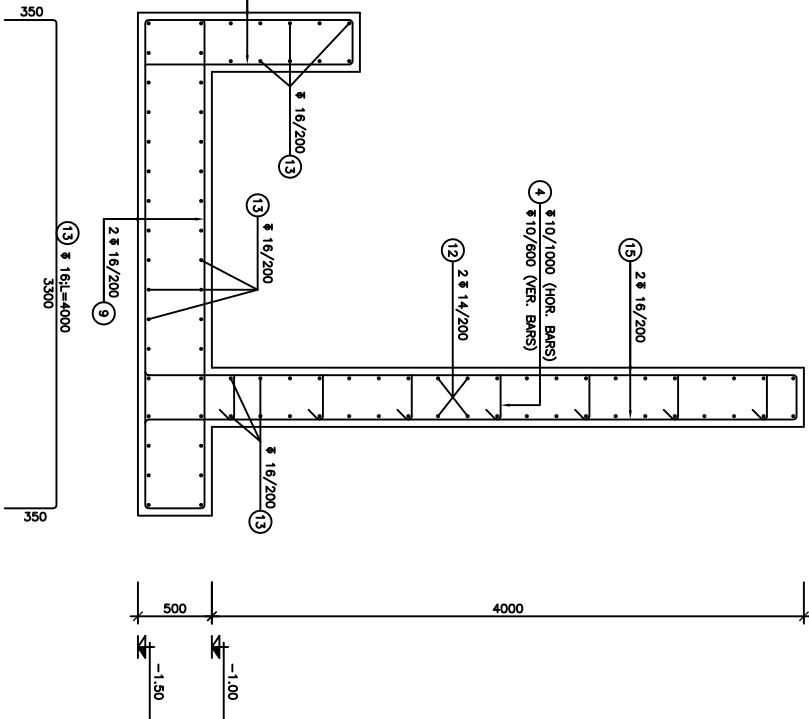

SUMP REINFORCEMENT

SCALE 1:25

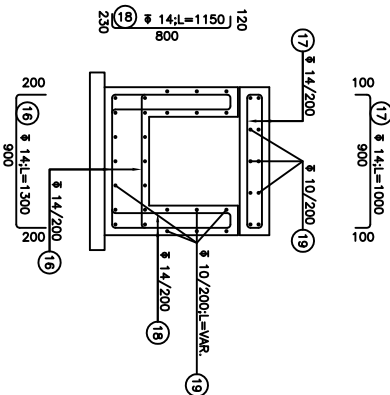

SECTION OF ELECTRICAL DUCT

SCALE 1:25

POS. NO.	Ø	LENGTH	MILL.	LENGTH PER POSITION M.						
				Ø 10	Ø 14	Ø 16	Ø 25			
BROUGHT FORWARD										
1	16	2.40	1500			3600				
2	16	1.40	1125			1575				
3	25	84.00	10				840			
4	16	78.00	12			936				
5	14	70.25	3		210.75					
6	14	83.10	3		249.3					
7	16	75.21	4			300.84				
8	16	81.77	4			327.08				
9	16	3.50	1760			6160				
10	16	4.50	1760			7920				
11	14	-	-		13596					
12	10	0.50	1104	552						
13	16	4.00	96			394				
14	16	2.00	44				88			
15	16	5.00	44				220			
16	14	1.30	120				156			
17	14	1.00	120				120			
18	14	1.15	240				276			
19	10	-	-	432						
CARRIED FORWARD										
TOTAL LENGTH M.		984		14608.052		1510.92		840		
UNIT WEIGHT Kg/m		0.617		1.208		1.578		3.853		
TOTAL WEIGHT Kg		607.13		17646.52		33944.23		3236.52		
GRAND TOTAL - KGS.				55434 - Kg						

Drawing Title: HEAVY FUEL OIL STORAGE TANK REINFORCEMENT DETAILS				Customer: PAYVAND_E_GOLESTAN			
General Arrangement Drawing							
Designed BY/WT AKS/AM	Date 28/7/2	Signature AKS/AM	Rev. 0	Description -	By R.D.	Date 28/7/2	Rev.
Checked AKS/AM							
Approved AKS/AM							
Project No.: 353	Scale: -	Drawing No.: 1.353.ST.14.5.05.00					